

SITE PLAN NOTES

1- EXISTING 5' SIDEWALK

2- EXISTING 20' WIDE DRIVEWAY

3- EXISTING 32' HICH BLOCK WALL WITH 6' HIGH TUBULAR STEEL FENCE ABOVE

4- EXISTING SLIDING GATES

5- EXISTING MAIL BOXES WILL BE REMOVED. A NEW MAIL BOXES WILL BE INSTALLED

6- EXISTING 600 AMP METER PANEL

7- EXISTING FENCE

8- EXISTING 5' HIGH PAINTED BLOCK WALL

9- THE BUILDING IS ON A SEPTIC SYSTEM

10- THE EXTERIOR OF THE BUILDING WILL BE MODIFIED TO MATCH THE FRONT UNIT

11- EXISTING STEEL CANOPY ABOVE

12- EXISTING CONC SLAB 30' X 30'

13- ANY PORTION OF THE PARKING LOT UNFINISHED WILL BE CORRECTED

14- AMERICANS WITH DISABILITES ACT (ADA) PARKING

15- REFUSE AREA

16- CONC DRIVE WAY

17- DEMISING WALLANT MIDPOINT

18- OFFICE AREA

19- HANDICAP TOILET 20-TYPICAL PARKING SPACE 9' X 20'

21- STOP SIGN

22- CAUTION PEDESTRIAN SIGN

23- STANDARD TRASH ENCLOSURE PER CITY BUILDING DEP. STANDARD

24- DECOMPOSED GRANITE WITH LANDSCAPING

(PALM SPINGS GOLD) THIS AREA

25- THE EXISTING SIGN ON TOP FENCE WILL BE REMOVED ALL EXISTING SIGNAGE WILL BE REMOVED AND THE SHADOWS BLENDED

26- EXISTING CARGO CONTAINER WILL BE REMOVED

27- TUBULAR STEEL FENCE TO MATCH EXISTING WROUGHT IRON FENCE AT FRONT OF EXISTING BLDG.

28 - EXISTING 175 WATT MERCURY VAPOR LIGHT FIXTURE WITH PHOTO CELL TIMER

29 - NEW 175 WATT MERCURY VAPOR LIGHT FIXTURE WITH PHOTO CELL TIMER (LED BR-1)

30 - NEW PLANTERS ALONG THE FRONT OF DOOR BAY

31 - EXISTING PLANTER ALONG THE FRONT OF DOOR BAY

32 - EXISTING DRAIN WILL BE REMOVED

36 - NEW 5' HIGH PAINTED BLOCK WALL

33- EXISTING WOOD FENCE

34 - DRAINAGE FLOW CHANNEL

35 - EXISTING ASPHALT

ENGINEERING NOTES

A- THE GRADE ELEVATIONS DIFFERENCE WILL BE REPAIR TO THE SATISFACTION OF THE CITY ENGINEER WITH D-CURB OR ANOTHER CITY APPROVED OPTION

B- THE EXISTING DRAIN WILL BE REMOVED

C- THE ASPHALT AREA WILL BE REPAVE WITH 3" A.C.TO MATCH CONCRETE ELEVATIONS AND REPAIR DRAINAGE AFTER REMOVAL OF THE DRAIN

D- THE PARKING STALLS WILL BE RESTRIPE

E-FEMA FLOOD ZONE X AREAS OF 0.2% ANNUAL CHANCE FLOOD. AREAS OF 1% ANNUAL CHANCE FLOOD WITH AVERAGE DEPTHS OF LESS THAN 1 FOOT

F- THE DRAIN WILL BE REMOVED AND ALL THE DRAINAGE FLOW WILL GO TO PEREZ ROAD AS INDICATED BY SLOPE INDICATOR

21- STOP SIGN

22- CAUTION PEDESTRIAN SIGN SCREEN ON EAST NEGHBORS LOT

36 - NEW 5' HIGH PAINTED BLOCK WALL

37 - ADA DRIVEWAY CITY STD SECTION 200-B COMMERCIAL

39 - ADA PÀTH OF TRAVEL TO THE SIDEWALK / PEDESTRIAN ENTRANCE

40 - ADA PÀTH OF TRAVEL TO THE SIDEWALK / PEDESTRIAN ENTRANCE 6' HIGH TUBULAR STEEL DOOR

41 - ADDRESS NUMBER SIGN

42 - FUTURE SIGNAGE

43 - $12\times14^{\circ}$ EXISTING ROLL UP DOOR WILL REMAIN - NO MATERIAL, WIDTH OR HEIGHT MODIFICATION WILL BE SEALED FROM THE INSIDE FOR SECURITY

44 - 10'x12' EXISTING ROLL UP DOOR WILL REMAIN - NO MATERIAL, WIDTH OR HEIGHT MODIFICATION WILL BE SEALED FROM THE INSIDE FOR SECURITY AND OUTSIDE WITH METAL SHEETING

46 - LOADING AREA 128'x10'

47 - DIAMOND PLANTERS

48 - ALL THE MECHANICAL EQUIPMENTS (A/A ETC) WILL BE INSTALED AT THE REAR OF THE BUILDING

PUBLIC UTILITIES PURVEYORS

SEWER; SEPTIC TANK - DESERT WATER

GAS: SOCALGAS

CABLE INTERNET & PHONE: SPECTUM & VONAGE

SOLID WASTE: BURRTEC WASTE DISPOSAL ELECTRIC: SOUTHERN CALIFORNIA EDISON

WATER; DESERT WATER

ECHINOCACTUS GRUSONII

5 GALLON BOX (DESERT MILKWEED) QUANTITY = 13

INERT MATERIAL



4" SWALE FOR MOUNDING



TYPE: DESERT SELECT DIAMETER SIZE AS NOTED ON PLAN IN FEET

SIZE: 3/8" MINUS, 11% FINES

PROJECT DATA

APN #: 687-322-007

LOT AREA: 20,995 SQ.FT.

EXISTING BLDG AREA: 4,500 SQ. FT.

OPEN CUTBACK AREA BETWEEN BLDGS: 120 SQ.FT. EXISTING STEEL CANOPY: 1,500 SQ. FT.

TOTAL BLDG AREA: 4,500 SQ. FT.

COVERAGE: 24.89%

ZONING: 1-1 DISPENSARY AREA: 1,500 SQ.FT. PARKING REQ'D: 1 PER 250 SQ. FT.

1.500 / 250 = 6

ZONING: 1-1 CULTIVATION AREA: 3,000 SQ.FT. PARKING REQ'D: 1 PER 1,000 SQ. FT.

3,000 / 1,000 = 3 PARKING REQUIRED: 9

PARKING PROVIDED: 18 WITH 1 VAN ACCESS HANDICAP

EXTRA PARKING PROVIDED: 9

OCCUPACY: S-3 NO WELDING ALLOWED CONSTRUCTION TIPE: 2N 12,000 SQ. FT. ALLOWABLE

SHRUBS & VINES



TREES

LEUCOPHYLLUM ZYCOPHYLLUM 5 GALLON BOX (CIMARRON)

NEW LANDSCAPE KEY

38 - THREE FOOT PLANTER EASTERLY SIDE OF PROPERTY

30 - NEW PLANTERS ALONG THE FRONT OF DOOR BAY

39 - PLANTER ADJACENT PARKING STALL 1

40 - STRIPPED AREA REAR OF PROPERTY

QUANTITY = 5

TIPUANA TUPU

QUANTITY = 6

ACACIA STENOPHYLLA

24" BOX (SHOESTRING ACACIA)

24" BOX (EVERGREEN SPECIES / YELLOW FLOWERS)



ASCLEPIAS SUBULATA

FERROCACTUS CYLINDRACEUS 5 GALLON BOX (FIRE BARREL CACTUS) QUANTITY = 13



BOULDER- 1/3 BURIED

24- DECOMPOSED GRANITE - BRIMSTONE DG 3 INCHES THICK AFTER COMPACTION

SHEET 0 : EXISTING SITE LANDSCAPE PLAN

2 SHEET 2 : EXTERIOR ELEVATIONS ROOF PLAN

CO2 INYECTION /CO2 ALARM


2-C SHEET 7 : EXTERIOR ELEVATIONS COLORED

LIGHTNING ILUMINATION PLAN

PP SHEET 10 : PHOTOMETRIC PLAN

R SHEET 11 : COLOR RENDERING - MATERIAL BOARD

ADJACENT USE: COMMERCIAL PROPERTY. BOB'S AUTO BODY/BJ POWDER COATING

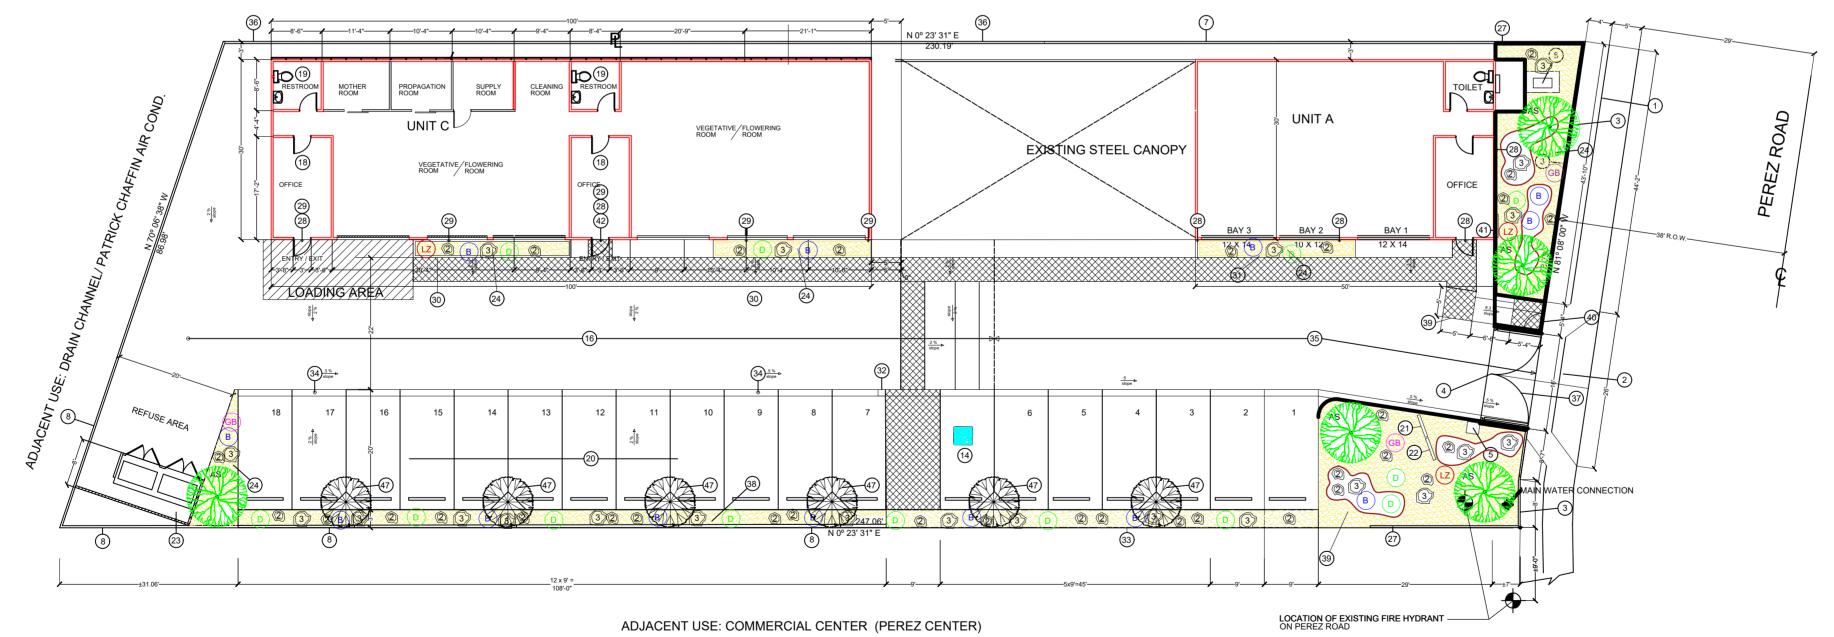

ALL GROWING ROOMS WILL HAVE SLIDING DOORS THE REAR OFFICE WIL BE HAVE RESTRICTED ACCESS ALL ROOMS WILL HAVE LIMITED ACCESS ALL EXISTING LANDSCAPE SHALL REMAIN



SHEET INDEX

1-P SHEET 1 : PROPOSED SITE LANDSCAPE PLAN FLOOR PLAN

SHEET 5 : UNIT B & C AIR HANDLING

6 SHEET 6 : INGRESS - EGRESS PLAN

L SHEET 8 : LANDSCAPE PLAN COLORED SHEET 9: UTILITIES - LOADING ZONES / PAVEMENT

ADA PÀTH OF TRAVEL

ACQUAFILA

MR. RICHARD GORDON

68415 PEREZ RD. CATHEDRAL CITY CALIFORNIA 92234

SITE ADDRESS

687-322-00

ARCHITECT

REVISIONS

PROJECT ENGINEER

ENG. LUIS ALBERTO CUENCA

ARCH. CESARE PELLATI S.

ENG. LUIS ALBERTO CUENCA ARCH. CESARE PELLATI S.

RESPONSIBLE PREPARING PLANS

ADDRESS

APPLICANT ACQUAFILA LLC

36334 DALI DR. CATHEDRAL CITY

CALIFORNIA 92234 PHONE

954-2844299 760-6203396 ACQUAFILA@GMAIL.COM

+(58) 212-9513290

ENG. LUIS ALBERTO CUENCA

COLORED LANDSCAPE

DATE: 01/08/2018 SCALE: 1/16"=1'0" DRAWN BY: C. PELLATI JOB: CUP APPLICATION