


## NOTES:

- 1. 3x3 TS @ 12" OC TRELLIS
- 2. 4x6 TS BEAM
- 3. 4x4 TS SUPPORT COLUMNS
- 4. SKIM COAT STUCCO
- 8X8X16 CONCRETE BLOCK. #4 REBAR VERT. @ 24" OC CENTERED; #4 REBAR HORIZ. BOND BEAM @ MID-HEIGHT AND TOP COURSE; SOLIDLY GROUTED; DECORATIVE BLOCK CAP.
- 6. 6" CONCRETE SLAB W/ #3 REBAR @ 18" OC EACH WAY OVER 90% COMPACTED BASE. 2% MIN. 4% MAX SLOPE TO DRAIN.
- 7. 6" CONCRETE CURB (WHEEL STOP), TYPICAL
  @ INSIDE PERIMETER.
- 8. SLIDE BOLT PER CITY STANDARDS.
- 9. CANE BOLT PER CITY STANDARDS.
- 10. 2x3 TS GATE FRAME, MITER CUT & WELD CORNERS; GRIND ALL CORNERS SMOOTH; 1-1/2" x 3/8" BAR STOP WELDED FLUSH WITH INSIDE FACE OF FRAME.
- ALTERNATIVE MATERIALS REQUEST SHALL BE SUBMITTED AND APPROVED PRIOR TO INSTALLATION, AS PER 2016 CBC 104.11

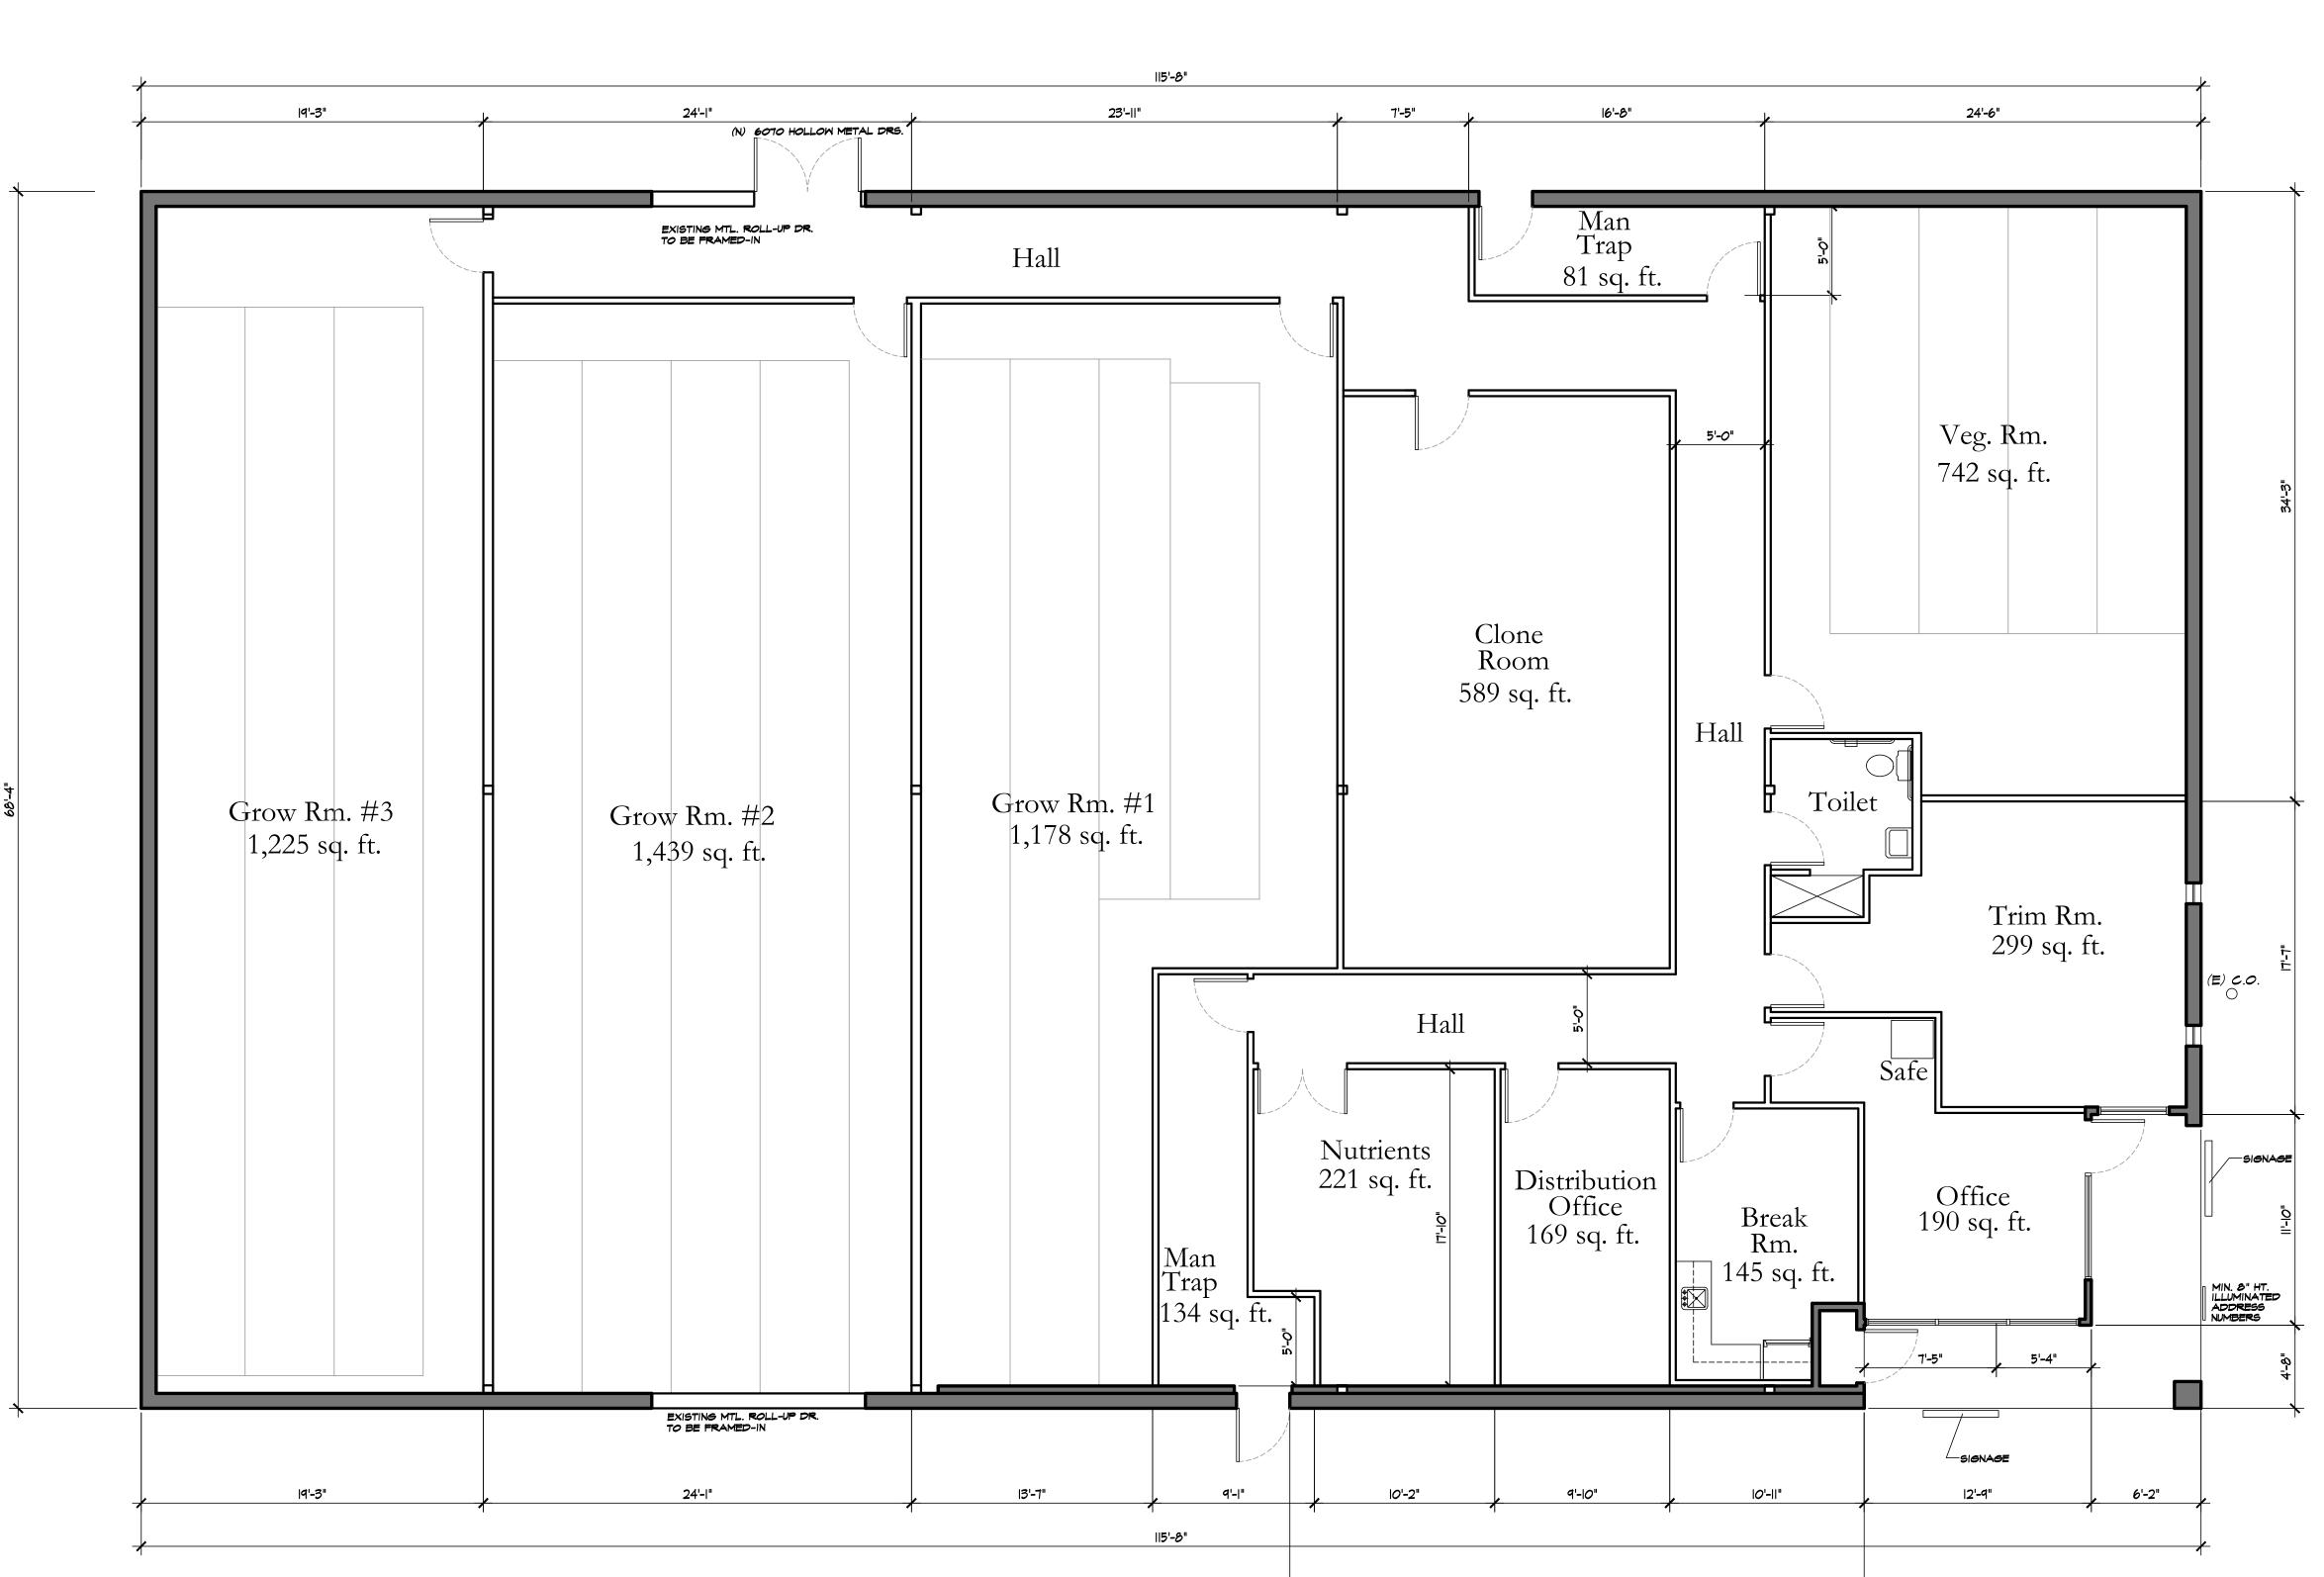

32'-3"

WALL/PARTITONS LEGEND

(EXISTING ) 2X WALLS

**FLOOR PLAN** 

3/16"=1'-0"

NEW 5 5/8" MTL STUDS @ 16" O.C. W/ 5/8" GYP. BD.

SHEET :

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· SHEET TITLE: · · · ·

FLOOR PLAN

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· AUGUST 2017 · · · SCALE · · · · AS NOTED· · ·

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